
CHECK FOR OTHER SERVICES BEFORE BORING OR EXCAVATING



PUBLIC LIGHTING DESIGN SHRIMPTONS CREEK USER PATH BETWEEN BRIDGE RD AND COOK STREET DETAILED LIGHTING DESIGN

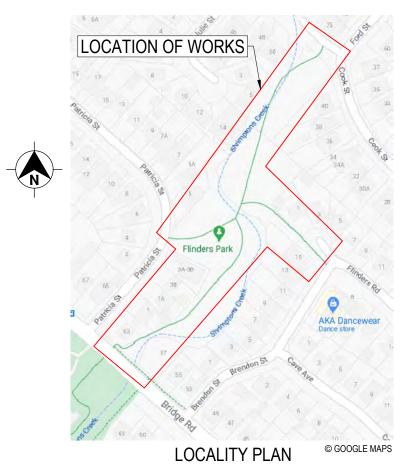


RED IN COLOUR AND MAY BE INCOMPLETE IF COPIED 0 135 140 145 150mm ON A3 SIZE ORIGINAL

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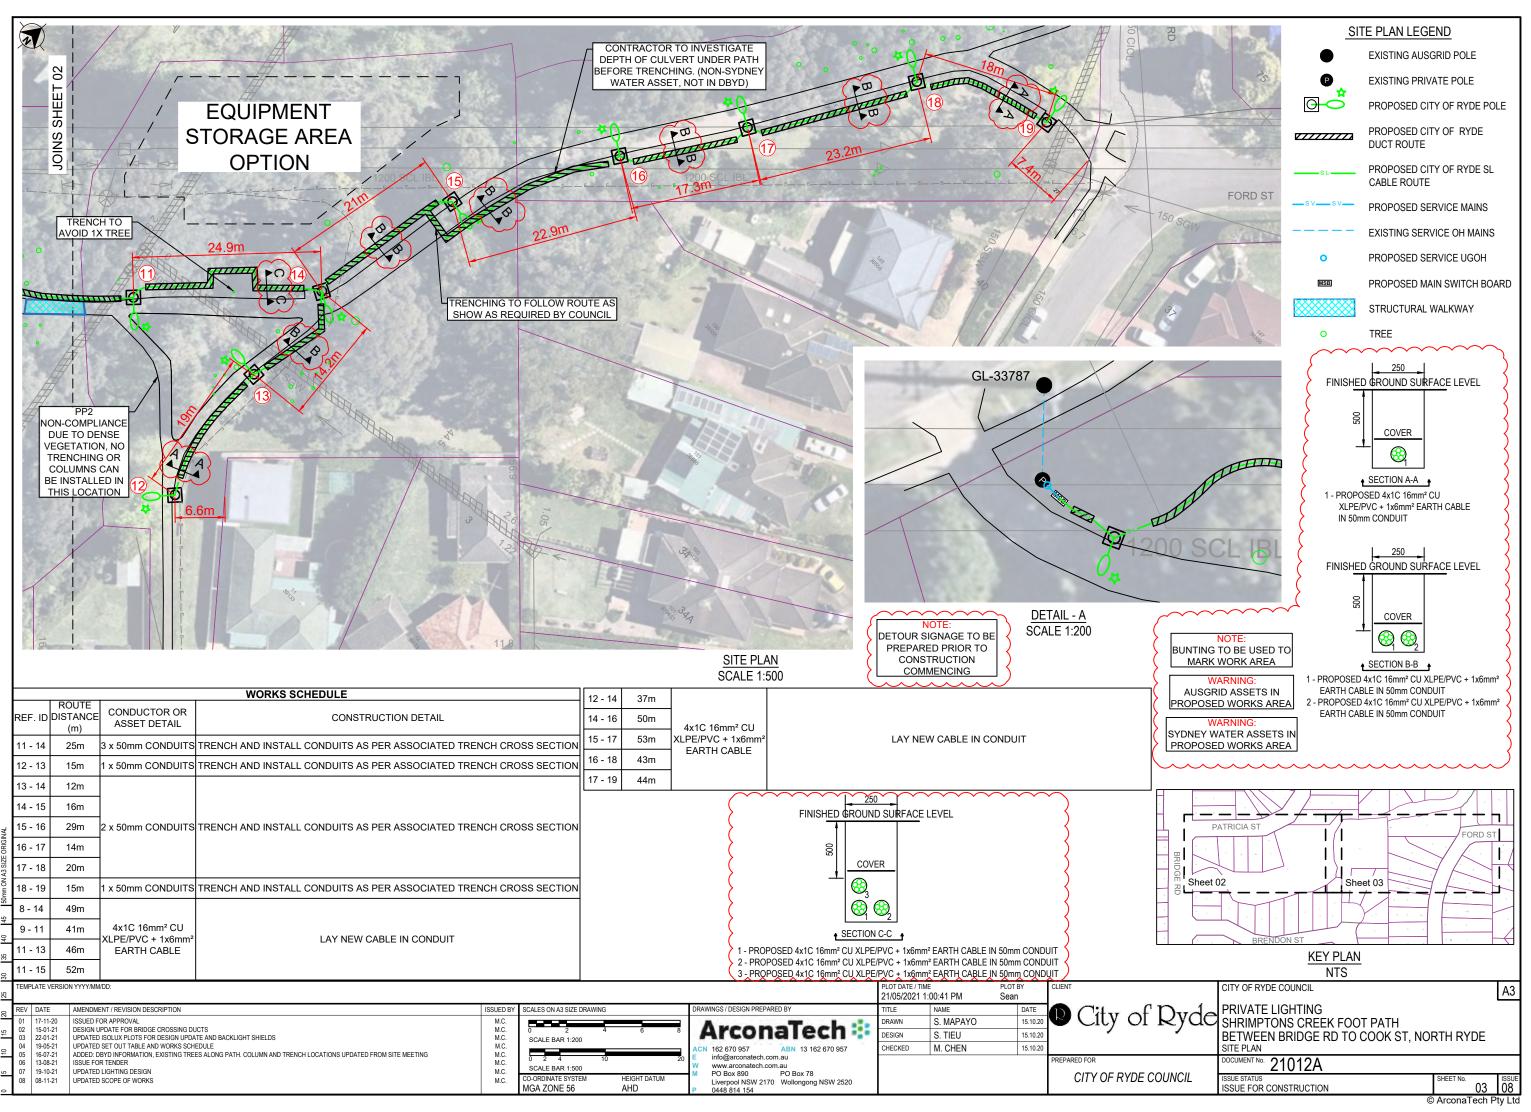
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<u>і</u> .	TEMPLATE VERSION YYYYMMDD:							CLIENT	CITY OF RYDE COUNCIL
									AU .
ц л g	REV DATE AMENDMENT / REVISION DESCRIPTION	ISSUED BY	SCALES ON A3 SIZE DRAWING	DRAWINGS / DESIGN PREPARED BY	TITLE	NAME	DATE	City of Dyde	PRIVATE LIGHTING
7 F	01 17-11-20 ISSUED FOR APPROVAL	M.C.		Avec me Tech !!	DRAWN	S. MAPAYO	15.10.20	🛡 City of Ryde	SHRIMPTONS CREEK FOOT PATH
हु स्	02 15-01-21 DESIGN UPDATE FOR BRIDGE CROSSING DUCTS 03 22-01-21 UPDATED ISOLUX PLOTS FOR DESIGN UPDATE AND BACKLIGHT SHIELDS	M.C.		ArconaTech 😫	DESIGN	S. TIEU	15.10.20		BETWEEN BRIDGE RD TO COOK ST, NORTH RYDE
	04 19-05-21 UPDATED SET OUT TABLE AND WORKS SCHEDULE	M.C.	NOT TO SCALE	ACN 162 670 957 ABN 13 162 670 957	CHECKED	M. CHEN	15.10.20		COVER SHEET
₹ 1	05 16-07-21 ADDED: DBYD INFORMATION, EXISTING TREES ALONG PATH. COLUMN AND TRENCH LOCATIONS UPDATED FROM SITE MEETING 06 13-08-21 ISSUE FOR TENDER	M.C.		E info@arconatech.com.au				PREPARED FOR	
	07 19-021 UPDATED LIGHTING DESIGN	M.C.		W www.arconatech.com.au M PO Box 890 PO Box 78					DOCUMENT NO. 21012A
≗ て	08 08-11-21 UPDATED SCOPE OF WORKS	M.C.	CO-ORDINATE SYSTEM HEIGHT DATUM	Liverpool NSW 2170 Wollongong NSW 2520				CITY OF RYDE COUNCIL	ISSUE STATUS SHEET NO. REV.
느 <u>~</u>			MGA ZONE 56 AHD	P 0448 814 154					ISSUE FOR CONSTRUCTION 01 08
									© ArconaTech Ptv L

SHEET INDEX							
NUMBER	DESCRIPTION	REV					
1	COVER SHEET	08					
2	SITE PLAN 01	08					
3	SITE PLAN 02	08					
4	COLUMN & FOUNDATION DETAILS	08					
5	SINGLE LINE DIAGRAM & MSB DETAILS	08					
6	GENERAL NOTES	08					
7	GENERAL NOTES	08					
8	LIGHTING CERTIFICATION - LUX DIAGRAM	08					
9	LIGHTING CERTIFICATION - LUX DIAGRAM	08					
0	LIGHTING CERTIFICATION - SOFTWARE OUTPUT	08					
1	LIGHTING CERTIFICATION - SOFTWARE OUTPUT	08					


FOR CONSTRUCTION

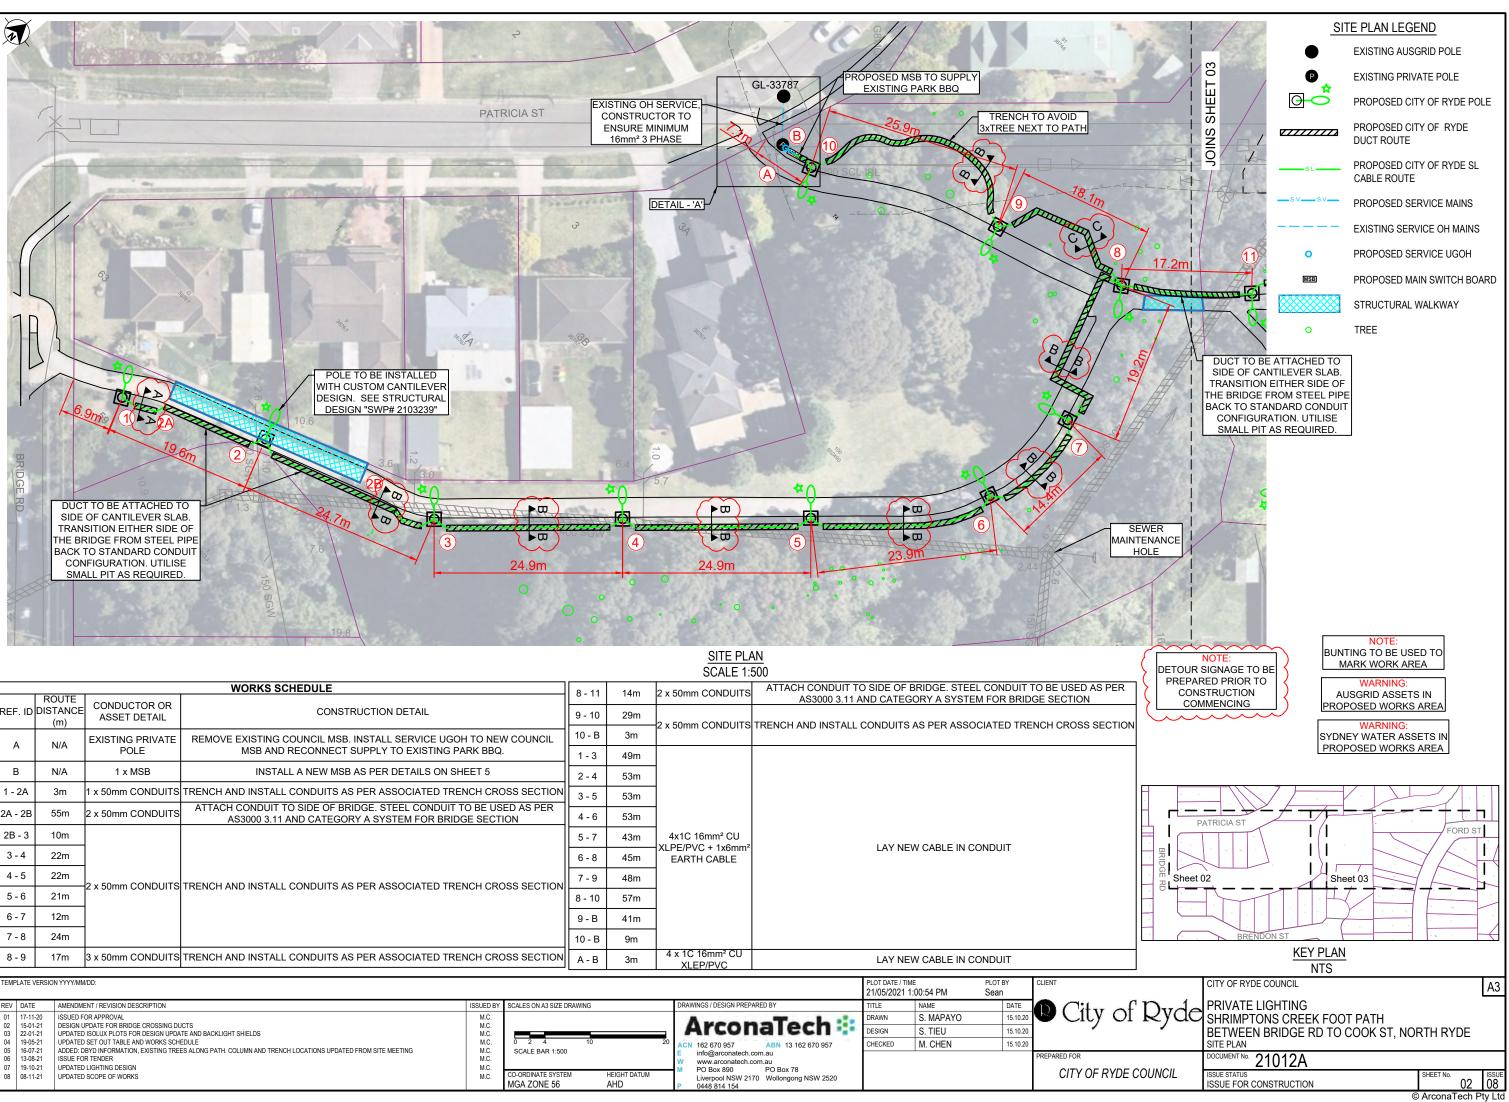

					SCALE 1:500								<pre>{</pre>		
	DOUTE		WORKS SCHEDULE	8 - 11	14m	2 x 50mm CONDUITS		TO SIDE OF BRIDGE. STEEL CONDUIT TO BE USE				PER			
REF. IC	REF. ID DISTANCE (m) CONDUCTOR OR ASSET DETAIL				9 - 10	29m	-2 x 50mm CONDUITS	AND CATEGORY A SYSTEM FOR BRIDGE SECTION							
А	N/A EXISTING PRIVATE REMOVE EXISTING COUNCIL MSB. INSTALL SERVICE UGOH TO NEW COUNCIL					10 - B	3m 49m								
В	N/A	1 x MSB	INSTALL A NEW MSB AS PER DETAILS ON SH	HEET 5		2 - 4	53m	-							
1 - 2A	3m	1 x 50mm CONDUITS	TRENCH AND INSTALL CONDUITS AS PER ASSOCIATED TRE	ENCH CRO	OSS SECTION	3 - 5	53m	1							
2A - 2B	55m	2 x 50mm CONDUITS	ATTACH CONDUIT TO SIDE OF BRIDGE. STEEL CONDUIT TO BE USED AS PER AS3000 3.11 AND CATEGORY A SYSTEM FOR BRIDGE SECTION				53m	-							
2B - 3	10m		S TRENCH AND INSTALL CONDUITS AS PER ASSOCIATED TRENCH CROSS SECTION			5 - 7	43m	4x1C 16mm ² CU							
3 - 4	22m						45m	- XLPE/PVC + 1x6mm² EARTH CABLE	LAY NEW CABLE IN CONDUIT				~		
4 - 5	22m				7 - 9	48m					~				
5 - 6	21m	-2 x 50mm CONDUITS			NCH CRUSS SECTION		57m								
6 - 7	12m					9 - B	41m								
7 - 8	24m						9m	-							
8 - 9	17m	3 x 50mm CONDUITS	TRENCH AND INSTALL CONDUITS AS PER ASSOCIATED TRE	ENCH CRO	OSS SECTION	A - B	3m	4 x 1C 16mm ² CU XLEP/PVC		LAY NEW CABLE IN CONDUIT					
TEMPLATE	VERSION YYYY/M	IM/DD:								PLOT DATE / T 21/05/2021	TIME 1:00:54 PM	PLOT BY Sean	CLIENT		
REV DAT	REV DATE AMENDMENT / REVISION DESCRIPTION ISSUED BY SCALES ON A3 SIZE D							DRAWINGS / DESIGN PREPA	ARED BY	TITLE	NAME	DATE	City	fr	
	12 15-01-21 DESIGN UPDATE FOR BRIDGE CROSSING DUCTS M.C. 13 22-01-21 UPDATED ISOLUX PLOTS FOR DESIGN UPDATE AND BACKLIGHT SHIELDS M.C.						Arcon	aTech 😫	DRAWN	S. MAPAYO	15.10.20		of R		
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06 130421 ISSUE FOR TENDER M.C. 07 19-10-21 UPDATED LIGHTING DESIGN M.C. 08 08-11-21 UPDATED SCOPE OF WORKS M.C.					HEIGHT DATUM	W www.arconatech.c M PO Box 890						RYDE COU			




REF. ID	CIRCUIT/	CONDUCTOR OR	STREETLIGHT WORKS SCHEDULE		E FOR POLE LOCATION RE AT CENTER OF POLES)
	PHASE	ASSET DETAIL		EASTING	NORTHING
1	С1/Вф	1 x 5m GM Pole	INSTALL GM POLE ACCORDING TO SITE PLAN AND COORDINATE TABLE	325019.961	6259104.773
2	C2/Bø	1 x 5m GM Pole	INSTALL GM POLE ACCORDING TO SITE PLAN AND COORDINATE TABLE	325036.444	6259115.595
3	C1/Aφ	1 x 5m GM Pole	INSTALL GM POLE ACCORDING TO SITE PLAN AND COORDINATE TABLE	325059.002	6259125.657
4	C2/Aφ	1 x 5m GM Pole	INSTALL GM POLE ACCORDING TO SITE PLAN AND COORDINATE TABLE CAUTION: EXISTING SW IN VINCINITY. REFER TO SITE PLAN AND DBYD	325075108	6259144.606
5	C1/Cφ	1 x 5m GM Pole	INSTALL GM POLE ACCORDING TO SITE PLAN AND COORDINATE TABLE	325091.299	6259163.579
6	C2/Cφ	1 x 5m GM Pole	INSTALL GM POLE ACCORDING TO SITE PLAN AND COORDINATE TABLE	325104.458	6259183.471
7	C1/Bø	1 x 5m GM Pole	INSTALL GM POLE ACCORDING TO SITE PLAN AND COORDINATE TABLE	325103.553	6259197.812
8	С2/Вф	1 x 5m GM Pole	INSTALL GM POLE ACCORDING TO SITE PLAN AND COORDINATE TABLE	325094.701	6259214.808
9	C1/Aφ	1 x 5m GM Pole	INSTALL GM POLE ACCORDING TO SITE PLAN AND COORDINATE TABLE	325078.148	6259207.465
10	C2/Aφ	1 x 5m GM Pole	INSTALL GM POLE ACCORDING TO SITE PLAN AND COORDINATE TABLE	325056.153	6259193.765
11	С1/Вф	1 x 5m GM Pole	INSTALL GM POLE ACCORDING TO SITE PLAN AND COORDINATE TABLE	325106.704	6259227.245
12	C2/Aφ	1 x 5m GM Pole	INSTALL GM POLE ACCORDING TO SITE PLAN AND COORDINATE TABLE	325130.117	6259214.401
13	C1/Cφ	1 x 5m GM Pole	INSTALL GM POLE ACCORDING TO SITE PLAN AND COORDINATE TABLE	325124.807	6259232.728
14	C1/Cφ	1 x 5m GM Pole	INSTALL GM POLE ACCORDING TO SITE PLAN AND COORDINATE TABLE	325122.304	6259246.657
15	C1/Cφ	1 x 5m GM Pole	INSTALL GM POLE ACCORDING TO SITE PLAN AND COORDINATE TABLE	325124.521	6259267.519
16	C2/Aφ	1 x 5m GM Pole	INSTALL GM POLE ACCORDING TO SITE PLAN AND COORDINATE TABLE CAUTION: EXISTING SW IN VINCINITY. REFER TO SITE PLAN AND DBYD	1 37513733	6259288.255
17	C1/Aφ	1 x 5m GM Pole	INSTALL GM POLE ACCORDING TO SITE PLAN AND COORDINATE TABLE CAUTION: EXISTING SW IN VINCINITY. REFER TO SITE PLAN AND DBYD	1 325142.469	6259303.532
18	C2/B¢	1 x 5m GM Pole	INSTALL GM POLE ACCORDING TO SITE PLAN AND COORDINATE TABLE	E 325152.45	6259324.488
19	С1/Вф	1 x 5m GM Pole	INSTALL GM POLE ACCORDING TO SITE PLAN AND COORDINATE TABLE	325167.697	6259334.038
	DATION NO	TE 2 ON SHEET 07.	NOTE: REFER TO STRUCTURAL E DRAWING "SWP# 2103239 CANTILEVER FOOTING DESIG	" FOR THE	225 SQ
			BASE PLATE REFER DETAIL.		
s		ION EDGE TO DTPATH EDGE		ATE TO SUIT GM POLES 4/M20 HIGH STRENGTH DUNDATION BOLTS ON A 233mm P.C.D.	BASE PLATE DETAIL

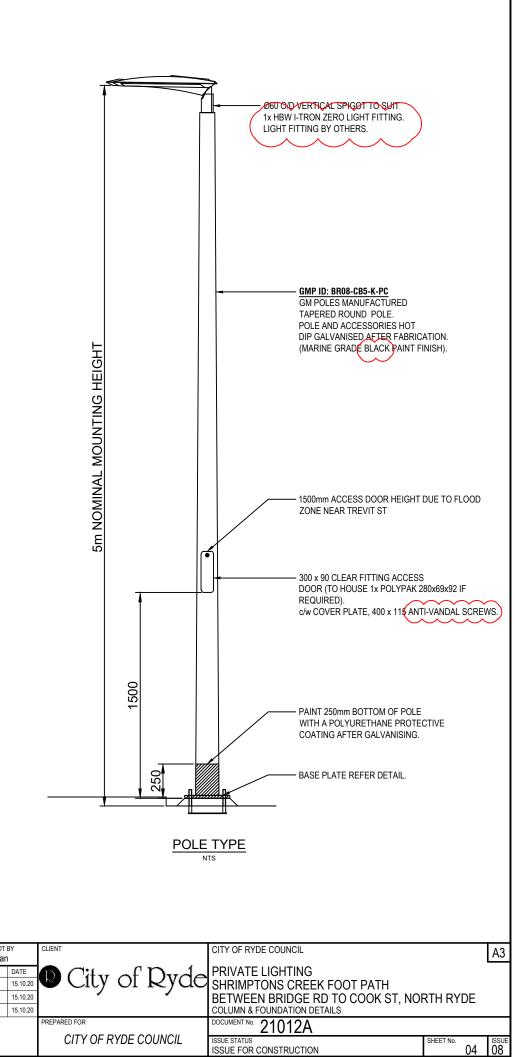


5m NOMINAL MOUNTING HEIGHT

500

© ArconaTech Pty Ltd

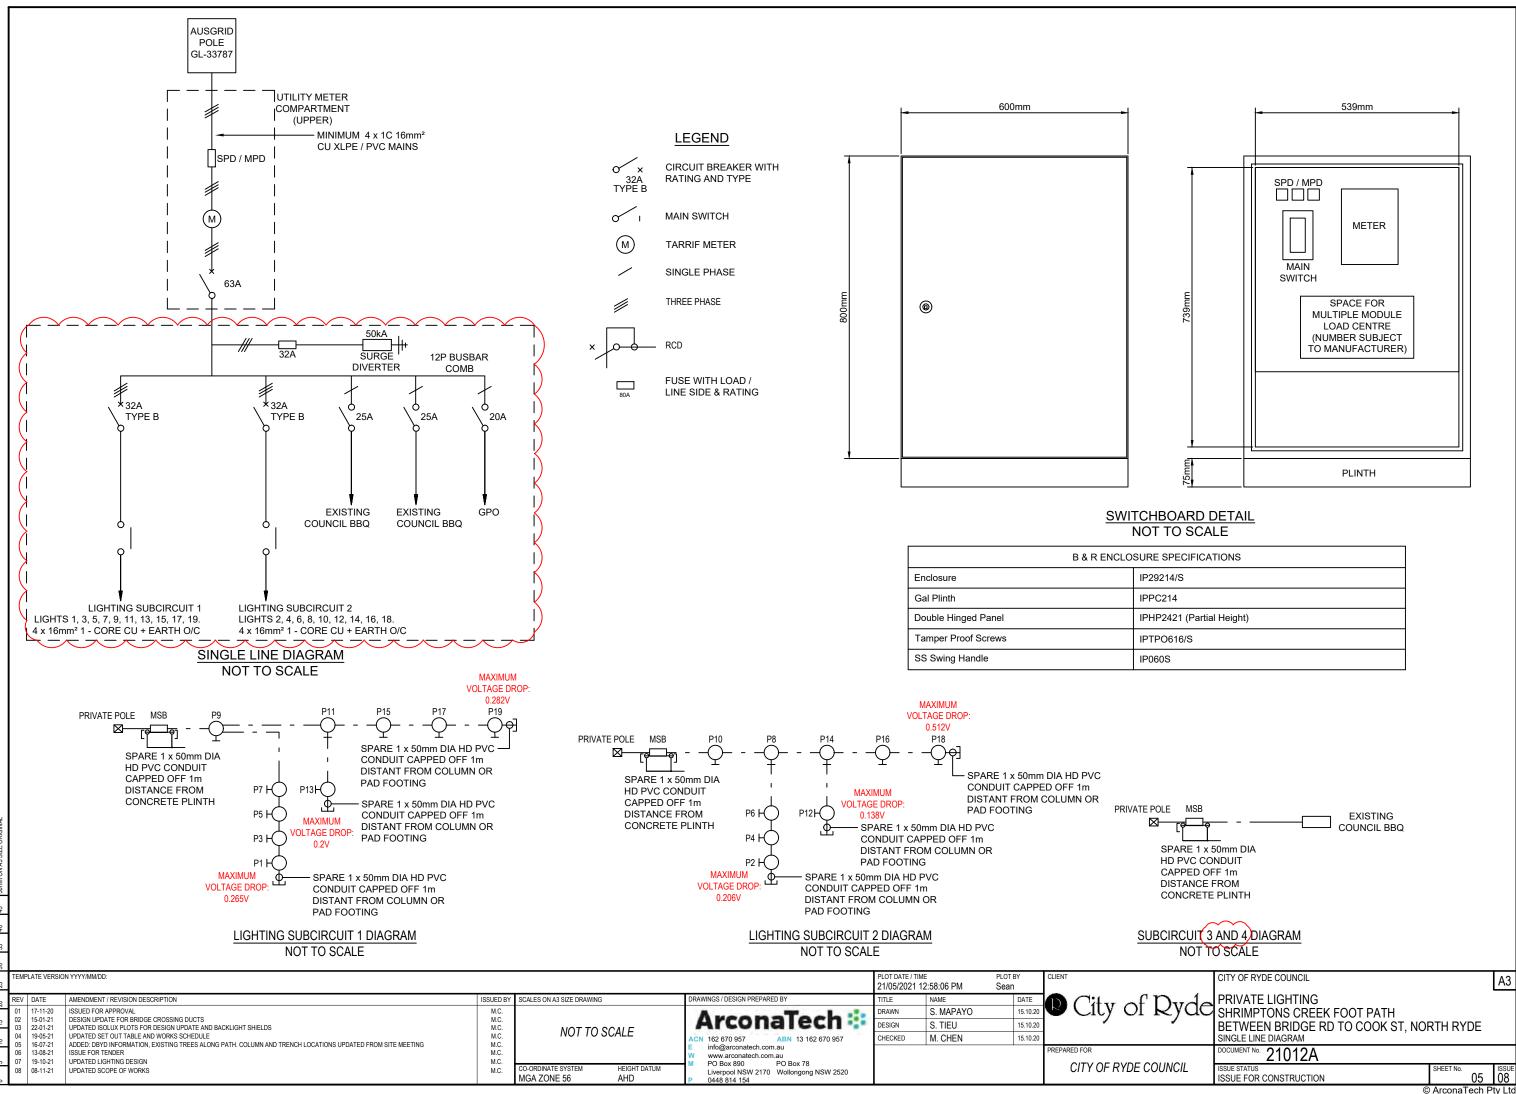

SOPI INCOMPLETE IF н Ш AND MAY COLOUR / |40 |45 ≅ ≌ RED Ř Ш DRAWING

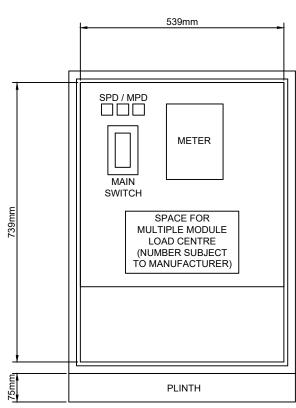

RESPECIFICATIONS
29214/S
PC214
HP2421 (Partial Height)
FPO616/S
060S

GENERAL NOTES

- THE ELECTRICAL CONTRACTOR IS TO VISIT SITE PRIOR TO PRICING TO SATISFY THEMSELVES OF THE SCOPE OF WORKS.
- PLANS HAVE BEEN PREPARED BASED ON SITE INVESTIGATION. DETAILED SURVEY HAS NOT BEEN 2. UNDERTAKEN.
- UPON COMPLETION OF THE WORKS. THE CONTRACTOR IS TO SUPPLY COUNCIL WITH A COPY OF THE WORKS 3 AS EXECUTED (WAE) DRAWINGS. IN PROGRESS WAE DRAWINGS MAY ALSO BE REQUESTED FROM TIME TO TIME BY RYDE COUNCIL FOR CO-ORDINATION PURPOSES
- ALL REMOVED & REDUNDANT MATERIALS TO BE APPROPRIATELY DISPOSED OF BY THE CONTRACTOR. 4
- WHILE NO RECORDS EXIST TO THE CONTRARY, THE CONTRACTOR SHALL ENSURE APPROPRIATE WORKPLACE 5 SAFETY MEASURES ARE UTILISED IN REGARDS TO WORKING WITH ASBESTOS AND/OR ASBESTOS CONTAINING MATERIALS.
- ALL WORK IS TO BE COMPLETED IN A PROFESSIONAL AND TRADESMAN LIKE QUALITY. 6
- ELECTRICAL AUTHORITY IS AUSGRID.
- ALL WORK SHALL BE CARRIED OUT IN ACCORDANCE WITH THE CURRENT REVISIONS OF THE BCA/NCC, AS/NZS 8. 3000. AS/ACIF S009. NSW SERVICE AND INSTALLATION RULES. AUSTRALIAN STANDARDS.
- 9 THE CONTRACTOR SHALL UNDERTAKE A "DIAL BEFORE YOU DIG" SEARCH FOR EXISTING IN-GROUND SERVICES NO MORE THAN 20 BUSINESS DAYS PRIOR TO EXCAVATION ON SITE. ANY DAMAGE TO EXISTING IN-GROUND SERVICES SHALL BE THE CONTRACTOR'S RESPONSIBILITY
- 10 THE EXISTING SERVICES SHOWN IN THE DRAWING PACKAGE HAVE BEEN DOCUMENTED FROM THE SUPPLIED DATA BY THE COUNCIL. ARCONATECH DOES NOT GUARANTEE OR TAKE RESPONSIBILITY OF THE ACCURACY OF THIS INFORMATION
- DESIGNER IS TO BE CONTACTED REGARDING ISSUES RAISED WITH THIS DESIGN. 11
- THE DESIGN CANNOT BE USED FOR CONSTRUCTION PURPOSES UNTIL THE LOCATION OF ALL EXISTING 12. SERVICES IS VERIFIED
- THE INFORMATION PROVIDED IN THIS DESIGN MUST BE CHECKED ON SITE AND THE MOST CURRENT 13. INFORMATION ON THE CONFIGURATION OF ALL SERVICES, INCLUDING AUSGRID'S NETWORK, MUST BE VERIFIED IMMEDIATELY BEFORE CONSTRUCTION COMMENCED BY CONTACTING DIAL-BEFORE-YOU-DIG BY TELEPHONE ON 1100 OR www.1100.com.au
- FOR DETAILS PLEASE REFER TO CITY OF RYDE DESIGN GUIDE, COUNCIL-OWNED STREET LIGHTING. 14
- THE CONTRACTOR TO DISCUSS WITH COUNCIL'S MAINTENANCE CONTRACTOR BEFORE INSTALLATION. 15
- ALL CO-ORDINATES PROVIDED ON THIS DESIGN ARE BASED ON AUSGRID'S GIS WHICH IS BASED ON DATA 16 FROM THE LPI. EXACT CO-ORDINATES TO BE CONFIRMED WITH THE CIVIL DRAWINGS AND SITE SURVEY. CADASTRAL SURVEYS MAY BE REQUIRED TO CONFIRM EXACT ASSET LOCATIONS.
- 17. INCLUDED SERVICE PLANS ARE QL-D. INFORMATION IS THE MOST BASIC LEVEL OF UTILITY LOCATIONS USING ONLY INFORMATION BASED ON EXISTING DIAL-BEFORE-YOU DIG PLANS.

TRENCHING & CABLING

- ELECTRICAL CONTRACTOR SHALL SAW CUT & EXCAVATE THE EXISTING SURFACE TO INSTALL NEW POLE LUMINAIRES. REINSTATE TRENCH WITH APPROPRIATE BACK FILL & COMPACTION, INCLUDING FINISHING OF TRENCH WITH COLD MIX ASPHALT OR TO MATCH WITH EXISTING FINISH. ALLOW FOR SLIGHT OVER FILL TO AVOID SAGGING, ALLOW FOR THESE WORKS TO BE UNDERTAKEN TO AVOID DISRUPTION DURING NORMAL WORKING DAYS/HOURS.
- STREET LIGHT MAINS TO HAVE 500mm COVER IN FOOTWAY, 750mm IN ROADWAY, 2
- CONTRACTOR TO LIAISE WITH COUNCIL AND AUTHORITIES ON THE UNDERGROUNDING PLACEMENT OF 3 ELECTRICAL CONDUIT.
- ALL CONDUITS MUST COMPLY WITH RELEVANT SECTIONS OF AS/NZS 2053 AND COUNCIL REQUIREMENT.
- ALL THE CABLE LAYING TO BE RECORDED IN COMPLIANCE WITH AS/NZS 3000. 5
- RADIUS OF BEND OF CABLE TO COMPLY WITH CABLE MANUFACTURE AND COUNCIL REQUIREMENTS. 6
- IF ANY EXCAVATION OR U/G WORKS ARE TO BE DONE ALL SURFACES MUST RESTORED TO ORIGINAL STATE UPON COMPLETION OF THE PROJECT.
- LOCATION OF CONDUITS ON FOOTPATH IS AS PER COUNCIL REQUIREMENT. 8
- CONTRACTOR TO LOCATE COMMS CONDUITS AS PER AUSTRALIAN STANDARD AND CITY OF RYDE COUNCIL'S 9. REQUIREMENT
- 10 ANY TRENCHING WITHIN 3m OF TREES WILL NEED SITE LIAISON WITH COUNCIL'S TREE MANAGEMENT OFFICERS BEFORE ANY WORKS COMMENCES.
- 11 TRENCHING ROUTE AND COLUMN LOCATIONS HAS BEEN DETERMINED WITH MULTIPLE SITE WALKS WITH COUNCIL, ARBORIST, AND IN CONJUNCTION OF COMMUNITY CONSULTATIONS.
- 12. CONTRACTOR TO CONTACT RYDE COUNCIL REGARDING ATTACHMENT METHODOLOGY TO EXISTING STRUCTURAL WALKWAYS.
- 13 WHERE EXISTING FOOTRATH, TRENCHING IS REQUIRED, FOOTPATH TO BE RE-MADE TO RYDE COUNCIL STANDARD CONCRETE FOOTPATH (CIV.5.1)

200mm

PATRICIA STREET Public Lighting Switchboard

City of Ryde PROPERTY OF CITY OF RYDE ENQUIRIES: 9952 8222

ASSET HANDOVER THE FOLLOWING SHALL BE PROVIDED TO COUNCIL PRIOR TO THE HANDOVER OF THE STREET LIGHTING INSTALLATION AND TRANSFER OF ENERGY ACCOUNT FROM THE DEVELOPER TO COUNCIL:

- CERTIFICATION FROM A CHARTERED STRUCTURAL ENGINEER (REGISTERED ON THE NER OF ENGINEERS, AUSTRALIA) CONFIRMING THAT THE WORKS HAVE BEEN CONSTRUCTED IN ACCORDANCE WITH COUNCIL-APPROVED DRAWINGS AND CITY OF RYDE'S STANDARDS AND SPECIFICATIONS. THE CERTIFICATE SHALL CONTAIN PHOTOGRAPHS OF THE WORKS IN PROGRESS AND A COMMENTARY OF THE INSPECTED WORKS, INCLUDING ANY DEFICIENCIES AND RECTIFICATIONS THAT WERE UNDERTAKEN; WORKS AS EXECUTED DRAWINGS;
- A SET OF ACCESS KEYS:

5.

IGA ZONE 56


- MANUFACTURER'S WARRANTIES AND CERTIFICATES;
- ASSET TAGS ON POLES AND METER BOX AS PER COUNCIL REQUIREMENTS;
- METER INFORMATION (NMI FROM AUSGRID) AND RELEVANT DETAILS FOR THE TRANSFER OF THE ENERGY 6 ACCOUNT TO COUNCIL NEEDS TO BE COMPLETED ON CCEW.

NOTE: A FINAL INSPECTION FOR THE PURPOSE OF THE HANDOVER TO COUNCIL SHALL BE CONDUCTED IN CONJUNCTION WITH COUNCIL'S ENGINEER, FOLLOWING THE COMPLETION OF THE WORKS. ADDITIONAL INSPECTIONS, IF REQUIRED, ARE SUBJECT TO ADDITIONAL FEES PAYABLE IN ACCORDANCE WITH COUNCIL'S CURRENT SCHEDULE OF FFES AND CHARGES

PUBLIC LIGHTING SWITCHBOARD TAG SPECIFICATION

- THE SIZE OF THE PLATE SHALL BE 200mm (LENGTH) X 60mm (HEIGHT). 2.
 - THE TEXT SIZE FOR THE STREET NAME AND FOR "PUBLIC LIGHTING SWITCHBOARD" IS TO BE 13mm TALL AND THE TEXT SIZE FOR "PROPERTY OF CITY OF RYDE, ENQUIRIES: 9952 822" IS TO BE 5mm. THE "CITY OF RYDE LOGO" IS TO BE 10mm TALL.
- THE PLATE IS TO HAVE A SILVER (STAINLESS STEEL) BACKGROUND WITH BLACK TEXT AND LOGO PRINT.
- THE LOGO AND TEXT ARE NOT TO BE STICKER LETTERING. 4
- THE MATERIAL OF THE PLATE AND THE ADHESIVE BACKING SHALL COMPLY WITH THE REQUIREMENTS OF THE DISTRIBUTION BOARD (GENERALLY STAINLESS STEEL).
- THE STREET NAME SHALL BE PRINTED WITHOUT ANY ABBREVIATIONS. IF THE STREET NAME IS TOO LONG IT 6 CAN BE PRINTED IN TWO LINES.
- "PUBLIC LIGHTING SWITCHBOARD" IS TO BE PRINTED IN THE CENTRE OF THE TAG.
- THE TAG BELOW WITH DIMENSIONS 60mm (LENGTH) X 30mm (HEIGHT) WITH "ELECTRICITY METER & MAIN 8. SWITCH" IS TO BE PLACED ON THE DOOR WITH THE METER WITHIN (THERE MAY BE TWO SEPARATE DOORS ONE FOR THE METER AND THE OTHER FOR THE DISTRIBUTION BOARD).

200mm

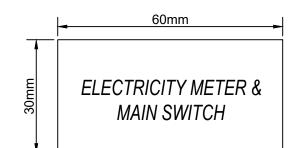

SHRIMPTON CREEK STREET N/ STREET NAME (13mm) ASSET LABEL (13mm) **XXXX-001** 60mm ASSET LABEL (13mm) -• City of Ryde PROPERTY OF CITY OF RYDE COUNCIL LOGO (10mm) COUNCIL LOGO (10mm) AND CONTACT & ENQUIRIES: 9952 8222 AND (NUMBER (5mm) NUMB LOT DATE / TI PLOT BY 21/05/2021 12:58:57 PM Sean AMENDMENT / REVISION DESCRIPTION CALES ON A3 SIZE DRAWING ISSUED BY TLE DATE 🕑 City of 15.10.20 S MAPAYO M.C RAWN M.C. M.C. M.C. M.C. M.C. ArconaTech 😳 DESIGN LIPDATE FOR BRIDGE CROSSING DUCTS ESIGN S. TIEU 15.10.20 UPDATED ISOLUX PLOTS FOR DESIGN UPDATE AND BACKLIGHT SHIELDS UPDATED SET OUT TABLE AND WORKS SCHEDULE NOT TO SCALE N 162 670 957 ABN 13 162 670 957 HECKED M. CHEN 15.10.20 ADDED: DBYD INFORMATION, EXISTING TREES ALONG PATH. COLUMN AND TRENCH LOCATIONS UPDATED FROM SITE MEETING info@arconatech.com.au www.arconatech.com.au M.C. M.C. PO Box 78 PO Box 890 CITY OF RYDE C 0-ORDINATE SYSTEM HEIGHT DATUM Perpool NSW 2170 Wollongong NSW 2520

0448 814 154

g ETE F BE INCOMPI AND MAY COLOUR / 140 145

60mm

REV DATE

17-11-20

15-01-21

22-01-2

16-07-21

13-08-21

19-10-2

08-11-21

EMPLATE VERSION YYYY/MM/DD

ISSUED FOR APPROVAL

ISSUE FOR TENDER

UPDATED LIGHTING DESIGN

UPDATED SCOPE OF WORKS

GENERAL

1 60mm (HEIGHT).

- 2.
- 3.
- 4. 5

8.

9.

MANUFACTURER (GENERALLY ANODISED ALUMINIUM).

6

- LONG. IT CAN BE PRINTED IN TWO LINES. 7.
- THE "CITY OF RYDE LOGO" IS TO BE 10mm TALL.
- STREET LIGHTS
- SYSTEMS DEPARTMENT
- DEPARTMENT

I IGHTING POLE TAG SPECIFICATION

THE SIZE OF THE PLATE SHALL BE 200mm (LENGTH MEASURED ALONG THE CURVATURE OF THE POLE) x

THE PLATE IS TO HAVE A SILVER (ALUMINIUM) BACKGROUND WITH BLACK TEXT AND LOGO PRINT THE LOGO AND TEXT ARE NOT TO BE STICKER LETTERING.

THE PLATE SHALL BE CURVED TO SUITE THE CURVATURE OF THE POLE.

THE MATERIAL OF THE PLATE AND RIVETS SHALL COMPLY WITH THE REQUIREMENTS OF THE POLE

THE STREET NAME SHALL BE PRINTED WITHOUT ANY ABBREVIATIONS. IF THE STREET NAME IS TOO

THE TEXT SIZE FOR THE STREET NAME AND FOR "POLE/ASSET NUMBER" IS TO BE 13mm TALL. THE TEXT SIZE FOR "PROPERTY OF CITY OF RYDE AND ENQUIRIES: 9952 8222" IS TO BE 5mm.

THE ASSET INDEX IS COMPILED VIA THE FOLLOWING RULES:

ASSET INDEX (STREET INDEX - 000) IS MADE UP BY COMBINING THE FOLLOWING TWO: 1. STREET INDEX - IS A FOUR-DIGIT NUMBER GIVEN TO EACH STREET BY COUNCIL'S ASSET

2.000 - A THREE-DIGIT SEQUENTIAL NUMBER PROVIDED BY COUNCIL'S ASSET SYSTEMS

AME	(13mm)
-----	--------

CONTACT ER (5mm)				
	CITY OF RYDE COUNCIL			A3
Ryde	PRIVATE LIGHTING SHRIMPTONS CREEK FOOT PATH BETWEEN BRIDGE RD TO COOK ST, NOF GENERAL NOTES	RTH RY	DE	
	DOCUMENT NO. 21012A			
OUNCIL	ISSUE STATUS ISSUE FOR CONSTRUCTION	SHEET No.	06	ISSUE
	C	ArconaT	ech P	ty Ltd

LIGHTING DESIGN

- ALL LUMINAIRES TO BE INSTALLED IN ACCORDANCE WITH THE MANUFACTURERS REQUIREMENTS AND 1. SPECIFICATIONS.
- 2. LIGHTING EQUIPMENT, LOCATION AND TYPES MAY NOT BE SUBSTITUTED WITHOUT PRIOR CONSENT AND APPROVAL OF THE DESIGNER. REFER IMAGE OF PROPOSED LUMINAIRE BELOW
- COLOUR/FINISH OF ALL LIGHT FITTINGS, TRIMS, LENSES AND ACCESSORIES TO BE APPROVED BY THE 3 COUNCIL. CONTRACTOR SHALL PROVIDE SAMPLES OF LIGHT FITTINGS PRIOR TO PROCUREMENT.
- NEW POLE LUMINAIRES ARE TO BE LOCATED TO AVOID CLASHES WITH EXISTING TREES, CONFIRM LOCATION 1 WITH LIGHTING DESIGNER PRIOR TO INSTALLATION. WHERE TREE BRANCHES ARE REQUIRED TO BE TRIMMED, THE AUTHORIZED PERSON IS TO BE ADVISED PRIOR TO ANY WORKS.



LOCKING

ALL STREET LIGHT SWITCHBOARDS SHALL BE LOCKED WITH A UNIQUE ABLOY KEY PADLOCK, AS DETAILED BELOW:

> Integrity ABLOY Key for all Street Lighting Switchboards

Master Key number associated with Registration Card 26060520 AUVG

INTEGRITY LOCKSMITHS AND SECURITY Utilities Security Key System

> Phone: 1300 664 582 1300 366 488

Fax. 1300 664 682

CUBICLE:

- 1. 2.0mm FOLDED AND WELDED STAINLESS STEEL SHEET CONSTRUCTION, SWITCHBOARD CABINET IS TO BE BASE MOUNTED VIA HOT DIPPED GALVANISED CHANNEL IRON PLINTH.
 - ESCUTCHEON SECURED TO CABINET WITH DOME NUTS.
 - 3. DOORS ARE SWUNG ON CHROME PLATED PINTLE HINGES AND FIXED WITH SWING HANDLES.

4. 3mm ALUMINUM GLAND PLATES FITTED TO BASE OF SWITCHBOARD.

FINISH: SHEETMETAL TO BE DEGREASED WITH SOLVENT, PHOSPHORIC ACID WASHED, AND CLEANED WITH 180 GRIT 1. PAPER. ELECTROSTATIC POLYESTER POWDER TO BE APPLIED AS FOLLOWS;

- CABINET EXTERIOR ORBITAL FINISH
- CABINET INTERIOR GLOSS WHITE
- ESCUTCHEONS GLOSS WHITE

PLINTH - 75mm HOT DIPPED GALVANISED

- LABELS: 1. LABELS ARE TO BE MACHINE ENGRAVED FROM 'GRAVOPLY' LAMINATE AND FIXED TO THE SWITCHBOARD METALWORK USING M3 SCREWS.
- BUSBARS:
- 1. NEUTRAL AND EARTH BARS TO BE LOCATED IN A POSITION WHERE THEY WILL NOT BE OBSTRUCTED BY SUBMAIN CABLES.
- 2. NEUTRAL BAR TO BE FULL RATING OF ACTIVES.
- 3. NEUTRAL AND EARTH TERMINATIONS TO BE NUMBERED TO CORRESPOND WITH RESPECTIVE SUBCIRCUIT NUMBERS THAT APPEAR ON LABELS.

SPECIFICATIONS.

- SWITCHBOARD MANUFACTURED TO AS 61439.2
- 2. FORM 2B SEPARATION TO AS 61439.2.
- IP66 CONSTRUCTION TO AS 60529. 3.
- 4. FAULT LEVEL 10kA FOR 1 SEC COMMERCIAL & INDUSTRIAL AREAS REQUIRE 25kA AS PER NSW SIR.
- 5. 415 VOLT, 50Hz M.E.N. LINK SYSTEM.
- MAINS CABLES BOTTOM ENTRY VIA 3mm ALUMINUM GLAND PLATE. 6.
- 7. SUBMAINS CABLES BOTTOM EXIT VIA 3mm ALUMINUM GLAND PLATE.

SUBCIRCUITS

1. 3-PHASE CB OR LINKED 1-PHASE CBS MUST BE UTILISED. THE USE OF UNLINKED 1-PH CBS IS NOT PERMITTED BY AS 3000.

EMPLATE VERSION YYYY/MM/DD PLOT BY LOT DATE / TIM 1/05/2021 12:59:16 PM Sean AMENDMENT / REVISION DESCRIPTION CALES ON A3 SIZE DRAWING AWINGS / DESIGN PREPARED BY ISSUED BY DATE REV DATE ITLE NAME City ot 15.10.20 ISSUED FOR APPROVAL S MAPAYO 17-11-20 M.C RAWN ArconaTech 🕸 M.C. M.C. M.C. M.C. M.C. M.C. DESIGN LIPDATE FOR BRIDGE CROSSING DUCTS 15-01-21 DESIGN S. TIEU 15.10.20 DESIGN OF DATE FOR BRIDGE CROSSING DUCIS UPDATED ISOLIX PLOTS FOR DESIGN UPDATE AND BACKLIGHT SHIELDS UPDATED SET OUT TABLE AND WORKS SCHEDULE ADDED: DBYD INFORMATION, EXISTING TREES ALONG PATH. COLUMN AND TRENCH LOCATIONS UPDATED FROM SITE MEETING 22-01-21 NOT TO SCALE N 162 670 957 ABN 13 162 670 957 CHECKED M. CHEN 15.10.20 16-07-21 13-08-21 info@arconatech.com.au ISSUE FOR TENDER www.arconatech.com.au PO Box 890 PC UPDATED LIGHTING DESIGN UPDATED SCOPE OF WORKS 19-10-21 M.C. M.C. PO Box 890 PO Box 78 Liverpool NSW 2170 Wollongong NSW 2520 CITY OF RYDE C 08-11-21 O-ORDINATE SYSTEM HEIGHT DATUM IGA ZONE 56 AHD 0448 814 154


FOUNDATION & COLUMN


THE INSTALLATION.

CENTER OF ALL LIGHTS TO SIT 225mm BEHIND THE FOOTPATH UNLESS OTHERWISE NOTED ON THE DESIGN. ALL POLES TO BE BLACK WITH MARINE GRADE PAINT FINISH.

STRAIGHT PILE IS STANDARD. CANTILEVERED IF SITE CONSTRAINTS REQUIRE IT - SUBMIT PROOF THIS FOOTING IS REQUIRED. THIS FOOTING MUST BE PREPARED BY A QUALIFIED STRUCTURAL ENGINEER REFERRED ON THE NER OF AUSTRALIA AND PROVIDED TO COUNCIL FOR REVIEW AND APPROVAL PRIOR TO


	CITY OF RYDE COUNCIL		A3
	PRIVATE LIGHTING SHRIMPTONS CREEK FOOT PATH BETWEEN BRIDGE RD TO COOK ST, NOF GENERAL NOTES	RTH RYDE	
	DOCUMENT No. 21012A		
OUNCIL	ISSUE STATUS ISSUE FOR CONSTRUCTION	SHEET No. 07	ISSUE
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LIGHTING DESIGN SCALE 1:500

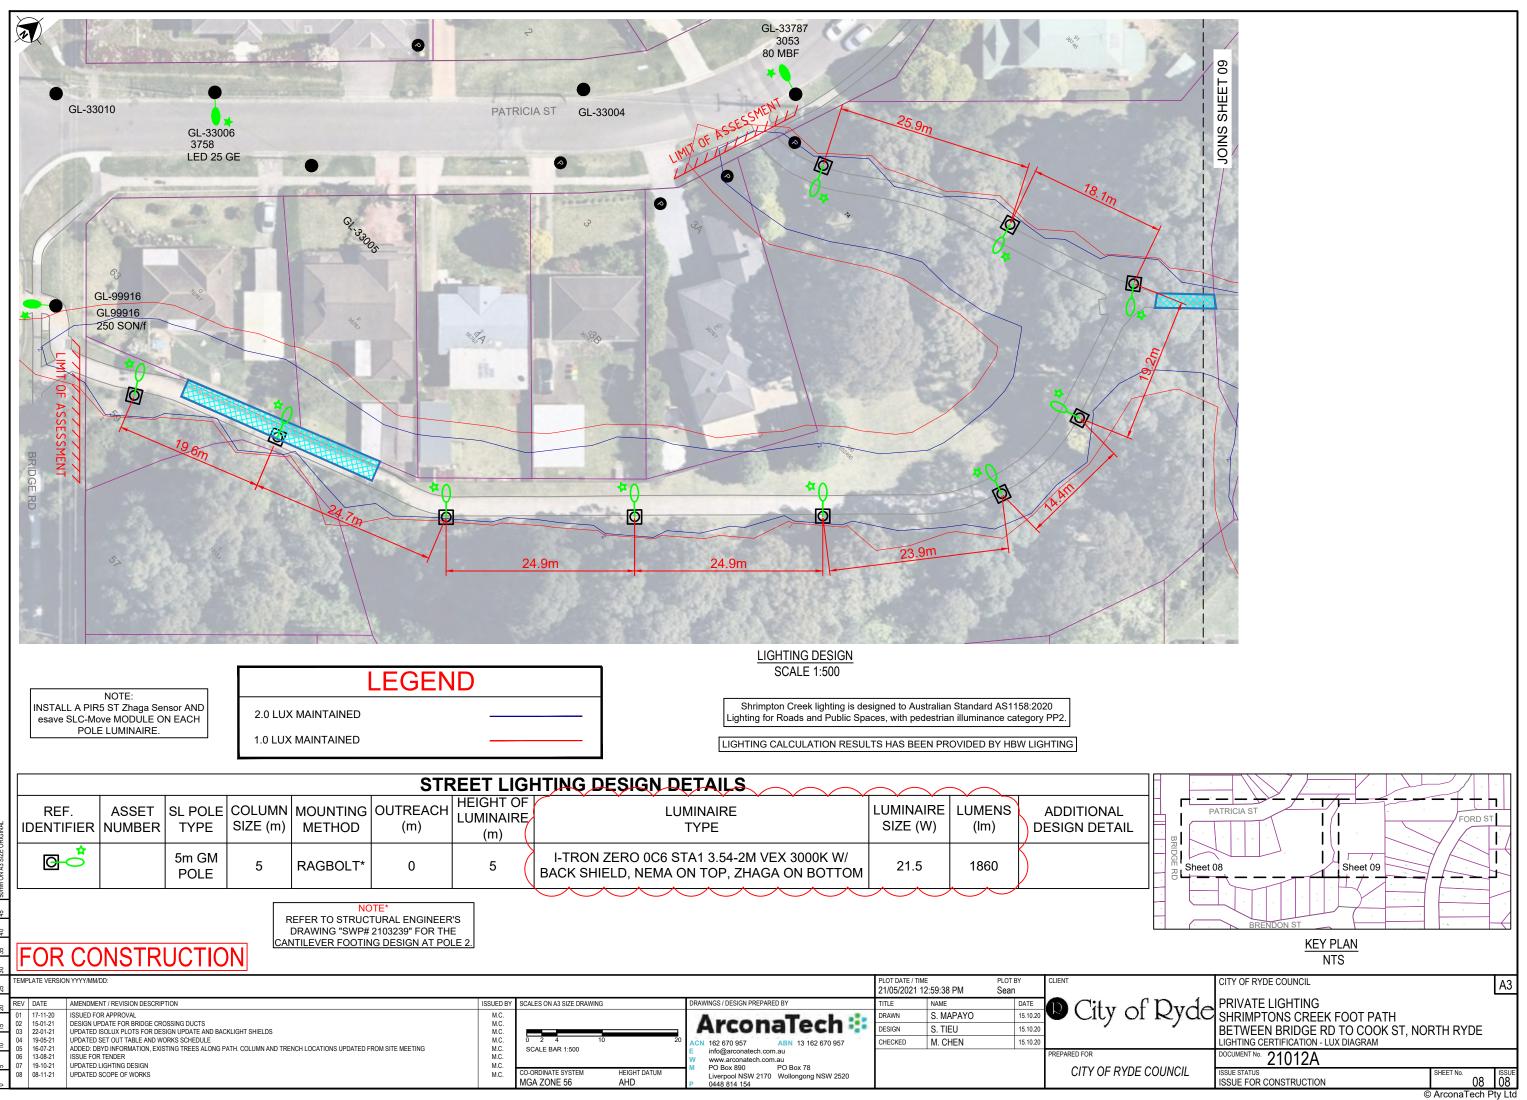25	TEMPL	LATE VERSIO	N YYYY/MM/DD:	PLOT DATE / TIME 21/05/2021 1:00:00 PM		PLOT BY Sean	CLIENT			
_ [REV	DATE	AMENDMENT / REVISION DESCRIPTION	ISSUED BY	SCALES ON A3 SIZE DRAWING	DRAWINGS / DESIGN PREPARED BY	TITLE	NAME	DATE	City of
		17-11-20	ISSUED FOR APPROVAL	M.C.		Awara Task t	DRAWN	S. MAPAYO	15.10.20	🕑 City oi
15		15-01-21 22-01-21	DESIGN UPDATE FOR BRIDGE CROSSING DUCTS UPDATED ISOLUX PLOTS FOR DESIGN UPDATE AND BACKLIGHT SHIELDS	M.C. M.C.		ArconaTech 😳	DESIGN	S. TIEU	15.10.20	
	04	19-05-21	UPDATED SET OUT TABLE AND WORKS SCHEDULE	M.C.	0 2 4 10 20	ACN 162 670 957 ABN 13 162 670 957	CHECKED	M. CHEN	15.10.20	
-		16-07-21 13-08-21	ADDED: DBYD INFORMATION, EXISTING TREES ALONG PATH. COLUMN AND TRENCH LOCATIONS UPDATED FROM SITE MEETING ISSUE FOR TENDER	M.C. M.C.	SCALE BAR 1:500	E info@arconatech.com.au W www.arconatech.com.au		-		PREPARED FOR
	07	19-10-21	UPDATED LIGHTING DESIGN	M.C.		M PO Box 890 PO Box 78				CITY OF RYDE
_	08	08-11-21	UPDATED SCOPE OF WORKS	M.C.	CO-ORDINATE SYSTEM HEIGHT DATUM MGA ZONE 56 AHD	Liverpool NSW 2170 Wollongong NSW 2520 P 0448 814 154				GITTOFRIDE

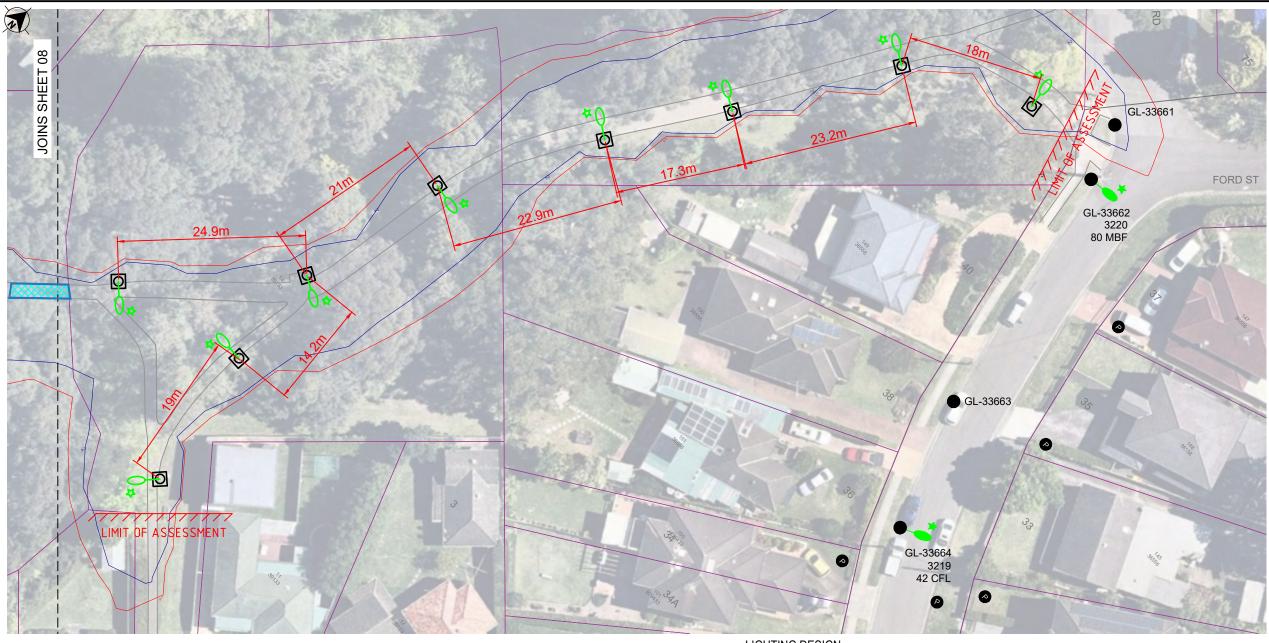

	P Category Lighting - AS/NZS 115		Light Technical Parameters at Max ***********************************										
	HBW Lighting					Mounting	g Path	Maximum		Eph			
	I-table Filename: C:\Users\steve\Desktop\I- M VEX AEP.cie	TRON	Zero 0C6 S	TA1 3.54-2		Height (m) 5.0	Width (m) 2.5	Spacing (m) 26.0	(1x) 7.59	(1x) 4.32			
	Job Name: Shrimptons Creek							20.0 l Illuminan					
	Luminaire Description: I-TRON Zero 0C6 STA1 1860	lmc				**	*******	********	******	*******			
	Initial Lamp Flux: 1860 lms) TIII2				Mounting	Height	= 5.0m Pa	th Widt	h = 2.5m			
	Maintenance Factor: 0.8 Stores Code:							< Gr	id acro	oss path -			
	Upcast Angle: 0 degrees Arrangement: Staggered Offset Distance: 0 m					(Luminaire . 13.44 13	•						
	Upward Waste Light Ratio: .0 % Light Source: LED - Light Emitting Dioc	ما				6.95 7	•						
	Luminaire Classification: Not specified					5.24 5 5.14 4							
	Lichting Catagony Have De Cined												
	Lighting Category: User Defined					4.32 4							
	Illuminance Criteria: Average Illuminance (E	Eav) >	= 7.00 lx			4.38 4	•						
	(Maintained values) Minimum Illuminance (E												
	Illuminance Uniformity (Vertical Illuminance (E					4.96 5							
	(Epv calculated on pl			ground		7.56 6							
	and contribution fro	om lum	inaire in			13.86 13							
	span used in calcula	ations)			20.74 16	•						
	Calculation Grid: Dependant on Path width (Luminaire) ۱	•	Illuminanc	e Value	s over Ca						
		of AS/NZS 1158.2)					***************************************						
	Mounting Maximum Spacing for diffe Height Path Widths	erent				(Luminaire	1)						
						. 11.16 12	· .38						
	2.5					11.49 10	•						
	5.0 26.0					14.93 12							
	++					12.08 12.36 9.94 10.91 7.41 7.83							
	Value/s in above table are all in metres. The table contains maximum spacings which, for the	ne sne	cified lum	inaire									
	and lamp combination, provide compliance with the					5.05 5.09							
	light technical parameters (LTPs) nominated above					3.29 3							
OPIED	Refer next page for list of LTP's at compliant ma Refer following page/s for illuminance values at						•						
EFC		8	p = co t			1.27 1 .84	.12						
APLET INAL							.47						
INCON ZE ORIG							.30						
AY BE DN A3 SI						(Luminaire NOTE: Valu	•	bove table	are in	Lux (rour			
ND M/								grid point		•			
0UR								d in determ	ining c	ompliance			
IN COLOUR AND MAY BE INCOMPLETE IF COPIED 35 40 45 50mm on A3 SIZE ORIGINAL					l		AS/NZS 2	1158.2.					
ARED 30 3													
PRE 25	ATE VERSION YYYY/MM/DD:						PLOT DATE / TIME 21/05/2021 1:00	PLOT BY	CLIENT				
REV REV 01	17-11-20 ISSUED FOR APPROVAL	ISSUED BY M.C.	SCALES ON A3 SIZE DRAW	NG	DRAWINGS / DESIGN F				DATE	City of			
	15:01-21 DESIGN UPDATE FOR BRIDGE CROSSING DUCTS 22:01-21 UPDATED ISOLUX PLOTS FOR DESIGN UPDATE AND BACKLIGHT SHIELDS 19:05:21 UPDATED SET OUT TABLE AND WORKS SCHEDULE	M.C. M.C. M.C.		O SCALE	Arco ACN 162 670 957	naTech			15.10.20				
05 06	16-07-21 ADDED: DBYD INFORMATION, EXISTING TREES ALONG PATH. COLUMN AND TRENCH LOCATIONS UPDATED FROM SITE MEETING 13-08-21 ISSUE FOR TENDER	M.C. M.C. M.C.			E info@arconate W www.arconate	ech.com.au ech.com.au			PREPARED				
	19-10-21 UPDATED LIGHTING DESIGN 08-11-21 UPDATED SCOPE OF WORKS	M.C. M.C.	CO-ORDINATE SYSTEM MGA ZONE 56	HEIGHT DATUM	M PO Box 890 Liverpool NSV P 0448 814 154	PO Box 78 W 2170 Wollongong NSW 2520			С	ITY OF RYDE C			

ers at Maximum Spac		
Eph Up (Emax/Eav) (lx)	<i>i</i>	
9 4.32 3		
lues over Calculati ******		
dth = 2.5m Spac	ing = 26.0m	
ross path> ues over Calculatio		
in Lux (rounded to 2 oss path, at Lumina ; compliance (refer	aire 1, not	A3
City of Ryde	PRIVATE LIGHTING SHRIMPTONS CREEK FOOT PATH BETWEEN BRIDGE RD TO COOK ST, NC LIGHTING CERTIFICATION - SOFTWARE OUT PUT	
PARED FOR CITY OF RYDE COUNCIL	DOCUMENT NO. 21012A ISSUE STATUS FOR APPROVAL	SHEET No. ISSUE 10 08
		© ArconaTech Pty Ltd

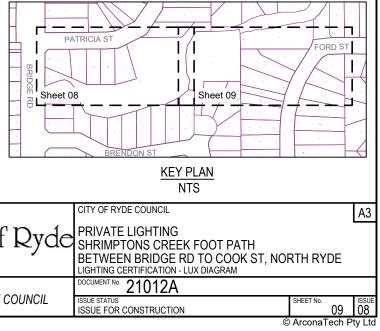SHEET No. 10 08 © ArconaTech Pty Ltd

	P Categ	ory Lighting - AS/NZS 1158 *******	8.3.1:2005 *******				chnical Pa		
		HBW Lighting			Mounting Height (m)	Path Width (m)	Maximum Spacing (m)	Eav (lx)	Eph ((lx)
	I-table Filename:	C:\Users\steve\Desktop\I- M VEX AEP.cie	TRON Zero 0C6 STA1 3.54-3	2	5.0	2.5	25.9	7.59	4.21
	Job Name:	Shrimptons Creek							
		I-TRON Zero 0C6 STA1 1860) lms				= 5.0m Pa		
	Initial Lamp Flux: Maintenance Factor:								
	Stores Code: Upcast Angle:	0 degrees			(Luminaire		Grid ac	ross pat	n>
	Arrangement:	Single Side				·			
	Offset Distance:				13.47 13				
	Upward Waste Light Ratio:	LED - Light Emitting Diod	le		6.99 7	•			
	Luminaire Classification:	5			5.26 5.15				
					4.38 4				
	Lighting Category:	User Defined			4.21 4	•			
	Illuminance Criteria:	Average Illuminance (E	av) >= 7.00 lx		4.21 4	.50			
	(Maintained values)	Minimum Illuminance (E	-		4.38 4	.53			
		Illuminance Uniformity (5.15 4				
		Vertical Illuminance (E			5.26 5				
			lane 1.5m above ground om luminaire in adjacent		6.99 7				
		span used in calcula	÷		13.47 13 16.86 20				
			· · · · · · · · · · · · · · · · · ·		(Luminaire	•			
	Calculation Grid:	Dependant on Path width ((refer Figure 3.8 of AS/NZS 1158.2)		V	ertical	Illuminanc ********		
	Mounting Height	Maximum Spacing for diffe Path Widths	rent		(Luminaire	, I			
					· 11.20 12	• 34			
	2.5				11.51 10				
	++ 5.0 25.9				14.96 12	•			
	++				12.10 12	.34			
	Value/s in above table a				9.96 10				
		mum spacings which, for th	•		7.43 7				
		rovide compliance with the ers (LTPs) nominated above			5.06 5 3.31 3				
		t of LTP's at compliant ma			2.05 1				
		for illuminance values at	grid points.		1.28 1				
		<u></u>	P	lePcat	.85	.73			
					•	.47			
					•	.30			
					(Luminaire NOTE: Valu	•	ove table	and in lu	uy (rour
							grid point		•
						included	in determ		-
						AS/NZS 1	158.2.		
	TE VERSION YYYYMMUDD:					PLOT DATE / TIME	PLOT BY	CLIENT	
						21/05/2021 1:00:	20 PM Sean		
1	DATE AMENDMENT / REVISION DESCRIPTION 77.11-20 ISSUED FOR APPROVAL 55-01-21 DESIGN UPDATE FOR BRIDGE CROSSING DUCTS		ISSUED BY SCALES ON A3 SIZE DRAWING M.C. M.C.		naTech 🏥			DATE (D) C	ity of

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	A TTTTANINUD.				21/05/2021 1		Sean	CELENT
ATE	AMENDMENT / REVISION DESCRIPTION	ISSUED BY	SCALES ON A3 SIZE DRAWING	DRAWINGS / DESIGN PREPARED BY	TITLE	NAME	DATE	City of Dyd
	ISSUED FOR APPROVAL	M.C.		Awaa ma Ta ah	DRAWN	S. MAPAYO	15.10.20	🛡 City of Ryd
	DESIGN UPDATE FOR BRIDGE CROSSING DUCTS UPDATED ISOLUX PLOTS FOR DESIGN UPDATE AND BACKLIGHT SHIELDS	M.C. M.C.		ArconaTech 😫	DESIGN	S. TIEU	15.10.20	
	UPDATED SET OUT TABLE AND WORKS SCHEDULE	M.C.	NOT TO SCALE	ACN 162 670 957 ABN 13 162 670 957	CHECKED	M. CHEN	15.10.20	
	ADDED: DBYD INFORMATION, EXISTING TREES ALONG PATH. COLUMN AND TRENCH LOCATIONS UPDATED FROM SITE MEETING ISSUE FOR TENDER	M.C. M.C.		E info@arconatech.com.au W www.arconatech.com.au				PREPARED FOR
	UPDATED LIGHTING DESIGN	M.C.		M PO Box 890 PO Box 78				CITY OF RYDE COUNCIL
3-11-21	UPDATED SCOPE OF WORKS	M.C.	CO-ORDINATE SYSTEM HEIGHT DATUM MGA ZONE 56 AHD	Liverpool NSW 2170 Wollongong NSW 2520 P 0448 814 154				
			1.15	F 0440 014 134				

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Up (Emax/Eav	Emax Ev (lx) (lx)	
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Calculati ********		
n Sp	 acing = 25.9m Grid	
	0.10	
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at Lumina	2 decimal places). ire 1, not	
e (reter	Figure 3.8	
	CITY OF RYDE COUNCIL	
' Ryde	PRIVATE LIGHTING SHRIMPTONS CREEK FOOT PATH	A3
-	BETWEEN BRIDGE RD TO COOK ST, NORTH R LIGHTING CERTIFICATION - SOFTWARE OUT PUT DOCUMENT NO. 21012A	YDE
COUNCIL	ISSUE STATUS SHEET NU FOR APPROVAL	11 ISSUE 08 aTech Pty Ltd
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